



DLCS Quality Endorsed Company ISO 9001:2008, Registration Number 20476 Nominated Architect: Nicholas Turner 6695, ABN 86 064 084 911

Thermal Comfort Specification			
Building Element	Material	Insulation	
External Wall	Cavity Brick, Brick-Veneer, Concrete, Hebel	None, R1.0, R1.5	
Internal Wall	Plasterboard on Stud	None	
Roof	Concrete	None	
Ceiling	Concrete above Plasterboard	None, R2.5*	
Floor	Concrete Slab	None, 0.5, 1.0*	
Floor Coverings	Carpet to Living and Bedrooms	N/A	
	Tiles to Bathrooms and Kitchens	.,,,,	
Windows	Group A Glazed Systems:	N/A	
	U-value = 6.7 & SHGC = 0.57, U- value = 5.4 & SHGC = 0.49*		
	Group B Glazed Systems:		
	U-value = 6.7 & SHGC = 0.70, U-		

Draught seals to all external windows and doors

STUDIO

1 BEDROOM UNIT 2 BEDROOM UNIT

3 BEDROOM UNIT

value = 5.4 & SHGC = 0.58*

Note: *Please refer to the BASIX Report for the individual insulation requirements of each residential dwelling

GENERAL ARRANGEMENT PLANS LEGEND

NOTE: WHERE NOMINATED ON DRAWINGS OR SCHEDULES A NUMERICAL SUFFIX INDICATES MULTIPLE TYPES I.E. BAL1=BALSTRADE TYPE 1, FIC REFER TO ARCHITECTURAL SCHEDULES FOR FURTHER INFORMATION

ACC Accessible
ACC Accessible
ACC Adaptable
APD Adaptable
B Battroom
B1,2.... Bedroom 1, Bedroom 2, etc.
BAL Balustrade
BKP Bicycle Parking
BKR Bicycle Rack
BKS Bicycle Storage
BL Bollard
BY Balcony
CL Centre Line
CLUR Cleaner Store
COL Column
COMS Communications Services
COS Check on Site
CPC Carpark Exhaust
CP Carpark Exhaust
CP Carpark Exhaust
CPC Carpark Exhaust
CPD Coll Water Supply
D Dining
DB Distribution Board
DRY Dyer
E E Insuite
ELECE Electrical Services
(EX) Existing
EXH Exhaust
F Fire Services
FIRE Fire Control Room
FEX Fire Starl Not. 12, etc.
FIRE Fire Hydraut
FFL Finished Floor Level
Fire Inflied Ground Level
FIRP Fire Mimic Panel
FEP_01,02. Fire Egress Passage No.1, 2, etc.
FFW Fire Mimic Panel
FEP_01,02. Fire Egress Passage No.1, 2, etc.
FW Floor Waste
GBC Garbage Chute
GBR Garbage Room
GL Ground Line
Hydraulic Services
HR Handrail
HRV Heavy Right Vehicle
HWW Hot Water unit
IL Invert Level
K Kitchen
K Kitchen
K Kitchen
K Mechanical Services
HR Handrail
HRV Heavy Right Vehicle
HWW Hot Water unit
IL Invert Level
K Kitchen
K Mechanical Services
HR Handrail
K Heavy Right Vehicle
HWW Hot Water unit
IL Invert Level
K Kitchen
K Mechanical Services
HR Handrail
K Heavy Right Vehicle
HWW Hot Water unit
IL Invert Level
K Kitchen
K Mechanical Services
HR Handrail
K Kitchen
K Mechanical Services
HR Handrail
K Redum Right Vehicle
HWS Hot Water Bervice
HWU Hot Water unit
IL Invert Level
K Kitchen
K Serb
L On Site Retention Tank
OV Ven
P Panity
P

CARPARK ENTRY EXISTING TREE PROPOSED TREE SILVER LEVEL LIVABLE UNIT ADAPTABLE UNIT RL RELATIVE LEVEL - TO AHD

Certificate no.: Assessor Name: Trong Thien Huynh
Accreditation no.: 20887 5.9

0001716160

Certificate date: 24 July 2017 Average star rating | Dwelling Address: NATIONWIDE HOUSE INFERCY RATING SCHEME 2145

Rev. Date Approved by Revision Notes

JM Development Application
JM Development Application Amendments U 03.07.17 JM Development Application Amendments 14.07.17 JM Development Application Amendments W 31.08.17 JM Development Application Amendments

CLIENT

DeicorpLevel 3, 161 Redfern Street, Redfern NSW 2016, Australia

Project Title

WSU - Lot 4 158-164 Hawkesbury Road, 2a Darcy Road Westmead NSW 2145 Australia

Drawing Title **GA Plans** Basement 01

For Information

Scale 1:200 @A1, 50%@A3

TURNER

L 7, ONE Oxford Street Darlinghurst NSW 2010 Australia

T +61 2 8668 0000 F +61 2 8668 0088 turnerstudio.com.au



DLCS Quality Endorsed Company ISO 9001:2008, Registration Number 20476 Nominated Architect: Nicholas Turner 6695, ABN 86 064 084 911

Thermal Comfort Specification		
Building Element	Material	Insulation
External Wall	Cavity Brick, Brick-Veneer, Concrete, Hebel	None, R1.0, R1.5
Internal Wall	Plasterboard on Stud	None
Roof	Concrete	None
Ceiling	Concrete above Plasterboard	None, R2.5*
Floor	Concrete Slab	None, 0.5, 1.0*
Floor Coverings	Carpet to Living and Bedrooms	N/A
. ioo. covegs	Tiles to Bathrooms and Kitchens	.,,,,
Windows	Group A Glazed Systems:	N/A
	U-value = 6.7 & SHGC = 0.57, U- value = 5.4 & SHGC = 0.49*	

value = 5.4 & SHGC = 0.58* Draught seals to all external windows and doors

Group B Glazed Systems: U-value = 6.7 & SHGC = 0.70, U-

Note: *Please refer to the BASIX Report for the individual insulation requirements of each residential dwelling

GENERAL ARRANGEMENT PLANS LEGEND

NOTE: WHERE NOMINATED ON DRAWINGS OR SCHEDULES A NUMERICAL SUFFIX INDICATES MULTIPLE TYPES I.E. BAL1=BALUSTRADE TYPE 1, FIC. REFER TO ARCHITECTURAL SCHEDULES FOR FURTHER INFORMATION

ACC Air Conditioning
ACC Accessible
ADP Adaptable
AHD Australian Height Datum
B B Bathroom
B1.2... Bedroom 1, Bedroom 2, etc.
BAL Balustrade
BKP Bicyde Parking
BKR Bicyde Storage
BL Boland
BY Balcony
CL Centre Line
CLNR Cleaner Slore
COL Column
CCMS Communications Services
COS Check on Site
CPE Car Park Exhaust
CP Carparing Space
CPD Cupboard
CPT Carpet
CY Courboard
CPT Courboard
CPT Carpet
CY Courboard
CPT Courboa

STUDIO 1 BEDROOM UNIT

2 BEDROOM UNIT 3 BEDROOM UNIT CARPARK ENTRY EXISTING TREE

PROPOSED TREE SILVER LEVEL LIVABLE UNIT ADAPTABLE UNIT RL RELATIVE LEVEL - TO AHD

Certificate no.: Assessor Name: Trong Thien Huynh
Accreditation no.: 20887 Certificate date: 24 July 2017 Average star rating | Dwelling Address:

NATIONWIDE HOUSE INERGY RATING SCHEME 2145

0001716160

Rev. Date Approved by Revision Notes

S 22.12.16 JM Development Application
T 22.06.17 JM Development Application Amendments
U 03.07.17 JM Development Application Amendments
V 14.07.17 JM Development Application Amendments

DeicorpLevel 3, 161 Redfern Street, Redfern NSW 2016, Australia

Project Title WSU - Lot 4

158-164 Hawkesbury Road, 2a Darcy Road Westmead NSW 2145 Australia Drawing Title

GA Plans Basement 02

1:200 @A1, 50%@A3

TURNER



DLCS Quality Endorsed Company ISO 9001:2008, Registration Number 20476 Nominated Architect: Nicholas Turner 6695, ABN 86 064 084 911

Thermal Comfort Specification		
Building Element	Material	Insulation
External Wall	Cavity Brick, Brick-Veneer, Concrete, Hebel	None, R1.0, R1.5*
Internal Wall	Plasterboard on Stud	None
Roof	Concrete	None
Ceiling	Concrete above Plasterboard	None, R2.5*
Floor	Concrete Slab	None, 0.5, 1.0*
Floor Coverings	Carpet to Living and Bedrooms	N/A
. ioo. coverings	Tiles to Bathrooms and Kitchens	, / .
Windows	Group A Glazed Systems:	N/A
	U-value = 6.7 & SHGC = 0.57, U- value = 5.4 & SHGC = 0.49*	

U-value = 6.7 & SHGC = 0.70, Uvalue = 5.4 & SHGC = 0.58* Draught seals to all external windows and doors

Group B Glazed Systems:

Note: *Please refer to the BASIX Report for the individual insulation requirements of each residential dwelling

GENERAL ARRANGEMENT PLANS LEGEND

NOTE: WHERE NOMINATED ON DRAWINGS OR SCHEDULES A NUMERICAL SUFFIX INDICATES MULTIPLE TYPES I.E. BAL1=BALUSTRADE TYPE 1, FIC. REFER TO ARCHITECTURAL SCHEDULES FOR FURTHER INFORMATION

STUDIO 1 BEDROOM UNIT 2 BEDROOM UNIT 3 BEDROOM UNIT

CARPARK ENTRY EXISTING TREE

PROPOSED TREE SILVER LEVEL LIVABLE UNIT ADAPTABLE UNIT RL RELATIVE LEVEL - TO AHD

ACC Air Conditioning
ACC Accessible
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B B Bathroom
B1.2... Bedroom 1, Bedroom 2, etc.
BAL Balustrade
BKP Bicyde Parking
BKR Bicyde Storage
BL Boland
BY Balcony
CL Centre Line
CLNR Cleaner Slore
COL Column
CCMS Communications Services
COS Check on Site
CPE Car Park Exhaust
CP Carparing Space
CPD Cupboard
CPT Carpet
CY Courboard
CPT Courboard
CPT Carpet
CY Courboard
CPT Courboa

Certificate no.: Assessor Name: Trong Thien Huynh
Accreditation no.: 20887 5.9 Certificate date: 24 July 2017 Average star rating | Dwelling Address:

0001716160

HOUSE
HOUSE
WESTMEAD, NSW
2145

Rev. Date Approved by Revision Notes

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V 14.07.17 JM Development Application Amendments

DeicorpLevel 3, 161 Redfern Street, Redfern NSW 2016, Australia

Project Title WSU - Lot 4

158-164 Hawkesbury Road, 2a Darcy Road Westmead NSW 2145 Australia Drawing Title

GA Plans Basement 03

For Information

1:200 @A1, 50%@A3

L 7, ONE Oxford Street Darlinghurst NSW 2010 Australia

TURNER



DLCS Quality Endorsed Company ISO 9001:2008, Registration Number 20476 Nominated Architect: Nicholas Turner 6695, ABN 86 064 084 911

Thermal Comfort Specification			
Building Element	Material	Insulation	
External Wall	Cavity Brick, Brick-Veneer, Concrete, Hebel	None, R1.0, R1.5*	
Internal Wall	Plasterboard on Stud	None	
Roof	Concrete	None	
Ceiling	Concrete above Plasterboard	None, R2.5*	
Floor	Concrete Slab	None, 0.5, 1.0*	
Floor Coverings	Carpet to Living and Bedrooms	N/A	
rioor coverings	Tiles to Bathrooms and Kitchens	.4	
Windows	Group A Glazed Systems:	N/A	
	U-value = 6.7 & SHGC = 0.57, U- value = 5.4 & SHGC = 0.49*		

value = 5.4 & SHGC = 0.58* Draught seals to all external windows and doors

Group B Glazed Systems: U-value = 6.7 & SHGC = 0.70, U-

Note: *Please refer to the BASIX Report for the individual insulation requirements of each residential dwelling

GENERAL ARRANGEMENT PLANS LEGEND

NOTE: WHERE NOMINATED ON DRAWINGS OR SCHEDULES A NUMERICAL SUFFIX INDICATES MULTIPLE TYPES I.E. BAL1=BALUSTRADE TYPE 1, FIC. REFER TO ARCHITECTURAL SCHEDULES FOR FURTHER INFORMATION

ACC Air Conditioning
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AHD Australian Height Datum
B B Bathroom
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BAL Balustrade
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BY Balcony
CL Centre Line
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COL Column
CCMS Communications Services
COS Check on Site
CPE Car Park Exhaust
CP Carparing Space
CPD Cupboard
CPT Carpet
CY Courboard
CPT Courboard
CPT Carpet
CY Courboard
CPT Courboa

STUDIO

1 BEDROOM UNIT 2 BEDROOM UNIT 3 BEDROOM UNIT CARPARK ENTRY

EXISTING TREE PROPOSED TREE SILVER LEVEL LIVABLE UNIT

ADAPTABLE UNIT ✓ RL

RELATIVE LEVEL - TO AHD

Certificate no.: Assessor Name: Trong Thien Huynh
Accreditation no.: 20887 Certificate date: 24 July 2017 Average star rating | Dwelling Address:

0001716160

HOUSE EVERCY RATING SCHEME
WSU
WESTMEAD, NSW
2145

Rev. Date Approved by Revision Notes

S 22.12.16 JM Development Application
T 22.06.17 JM Development Application Amendments
U 03.07.17 JM Development Application Amendments
V 14.07.17 JM Development Application Amendments

DeicorpLevel 3, 161 Redfern Street, Redfern NSW 2016, Australia


Project Title

WSU - Lot 4 158-164 Hawkesbury Road, 2a Darcy Road Westmead NSW 2145 Australia

Drawing Title **GA Plans** Basement 04

1:200 @A1, 50%@A3

TURNER

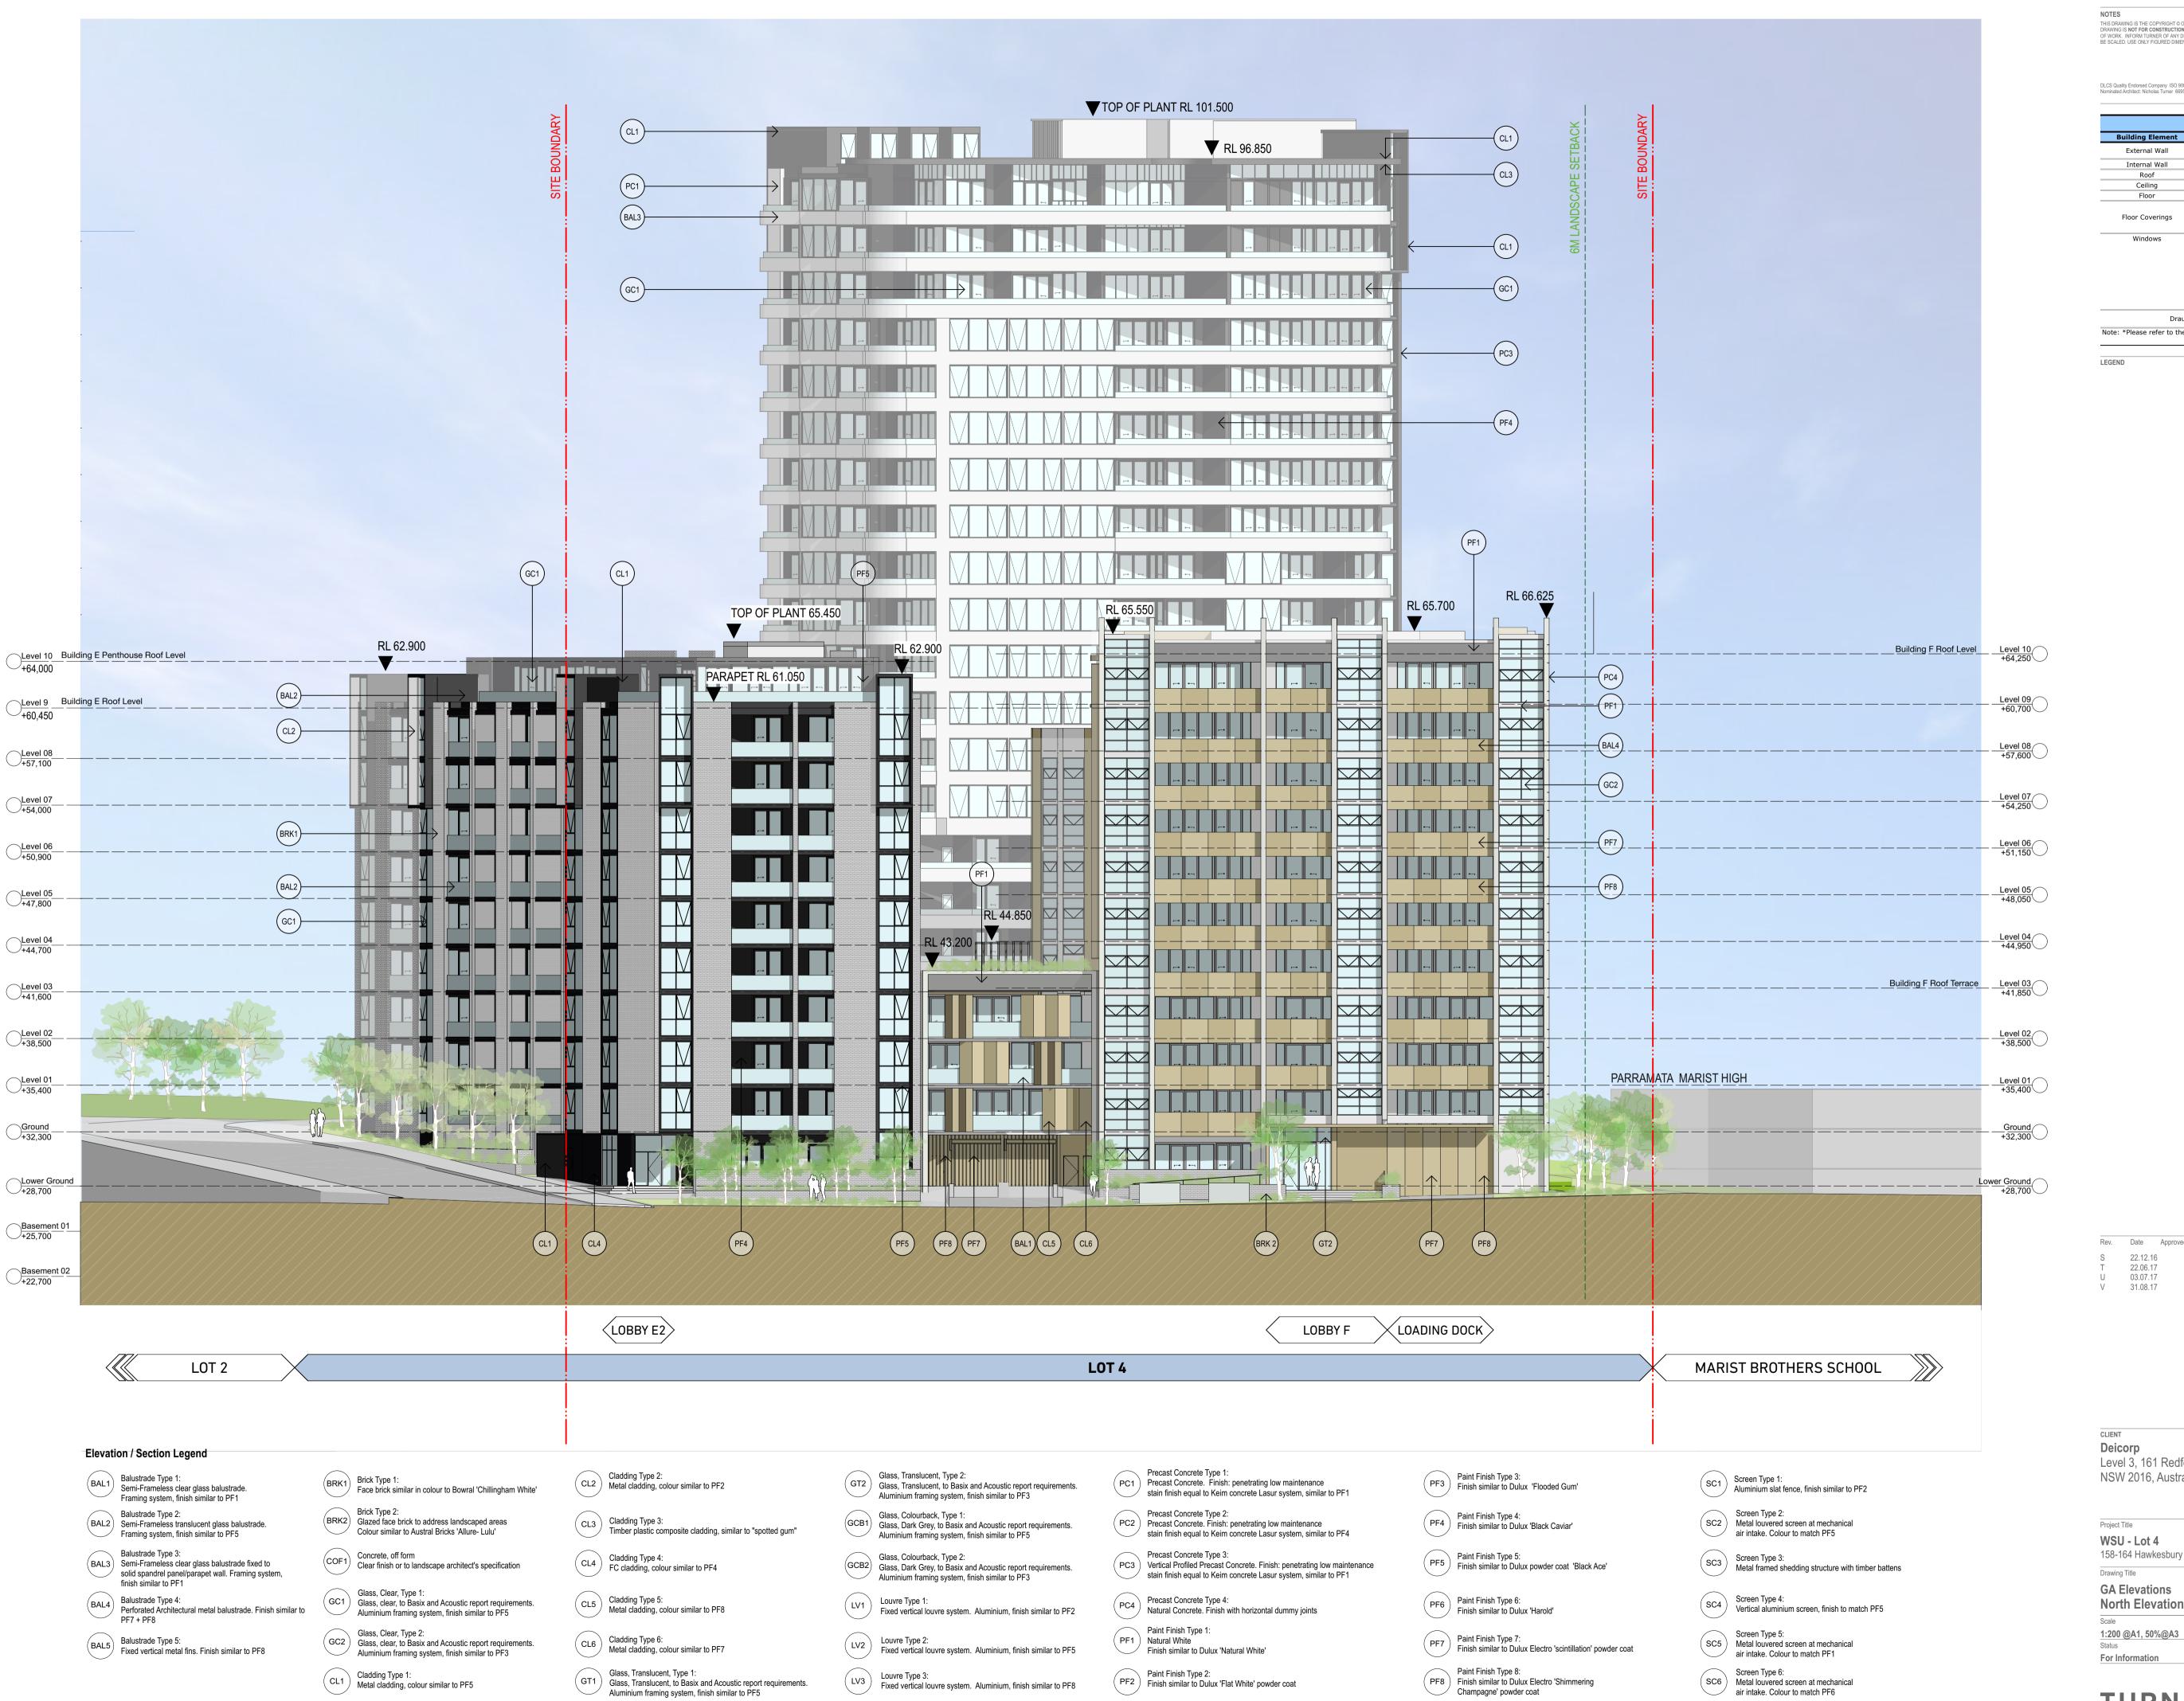

DLCS Quality Endorsed Company ISO 9001:2008, Registration Number 20476 Nominated Architect: Nicholas Turner 6695, ABN 86 064 084 911

Thermal Comfort Specification			
Building Element	Material	Insulation	
External Wall	Cavity Brick, Brick-Veneer, Concrete, Hebel	None, R1.0, R1.5	
Internal Wall	Plasterboard on Stud	None	
Roof	Concrete	None	
Ceiling	Concrete above Plasterboard	None, R2.5*	
Floor	Concrete Slab	None, 0.5, 1.0*	
Floor Coverings	Carpet to Living and Bedrooms	N/A	
we i		N1/A	
Windows	Group A Glazed Systems: U-value = 6.7 & SHGC = 0.57, U-value = 5.4 & SHGC = 0.49*	N/A	
	Group B Glazed Systems:		

Draught seals to all external windows and doors Note: *Please refer to the BASIX Report for the individual insulation requirements of each residential dwelling

U-value = 6.7 & SHGC = 0.70, Uvalue = 5.4 & SHGC = 0.58*



Certificate no.: Assessor Name: Accreditation no.: 5.9 Certificate date: Dwelling Address: HOUS WESTMEAD, NSW

0001716160

24 July 2017

20887

Trong Thien Huynh

Rev. Date Approved by Revision Notes

JM Development Application 22.06.17 JM Development Application Amendments 03.07.17 JM Development Application Amendments JM Development Application Amendments


Level 3, 161 Redfern Street, Redfern NSW 2016, Australia

158-164 Hawkesbury Road, 2a Darcy Road Westmead NSW 2145 Australia

GA Elevations North Elevation

turner DA-210-001

TURNER

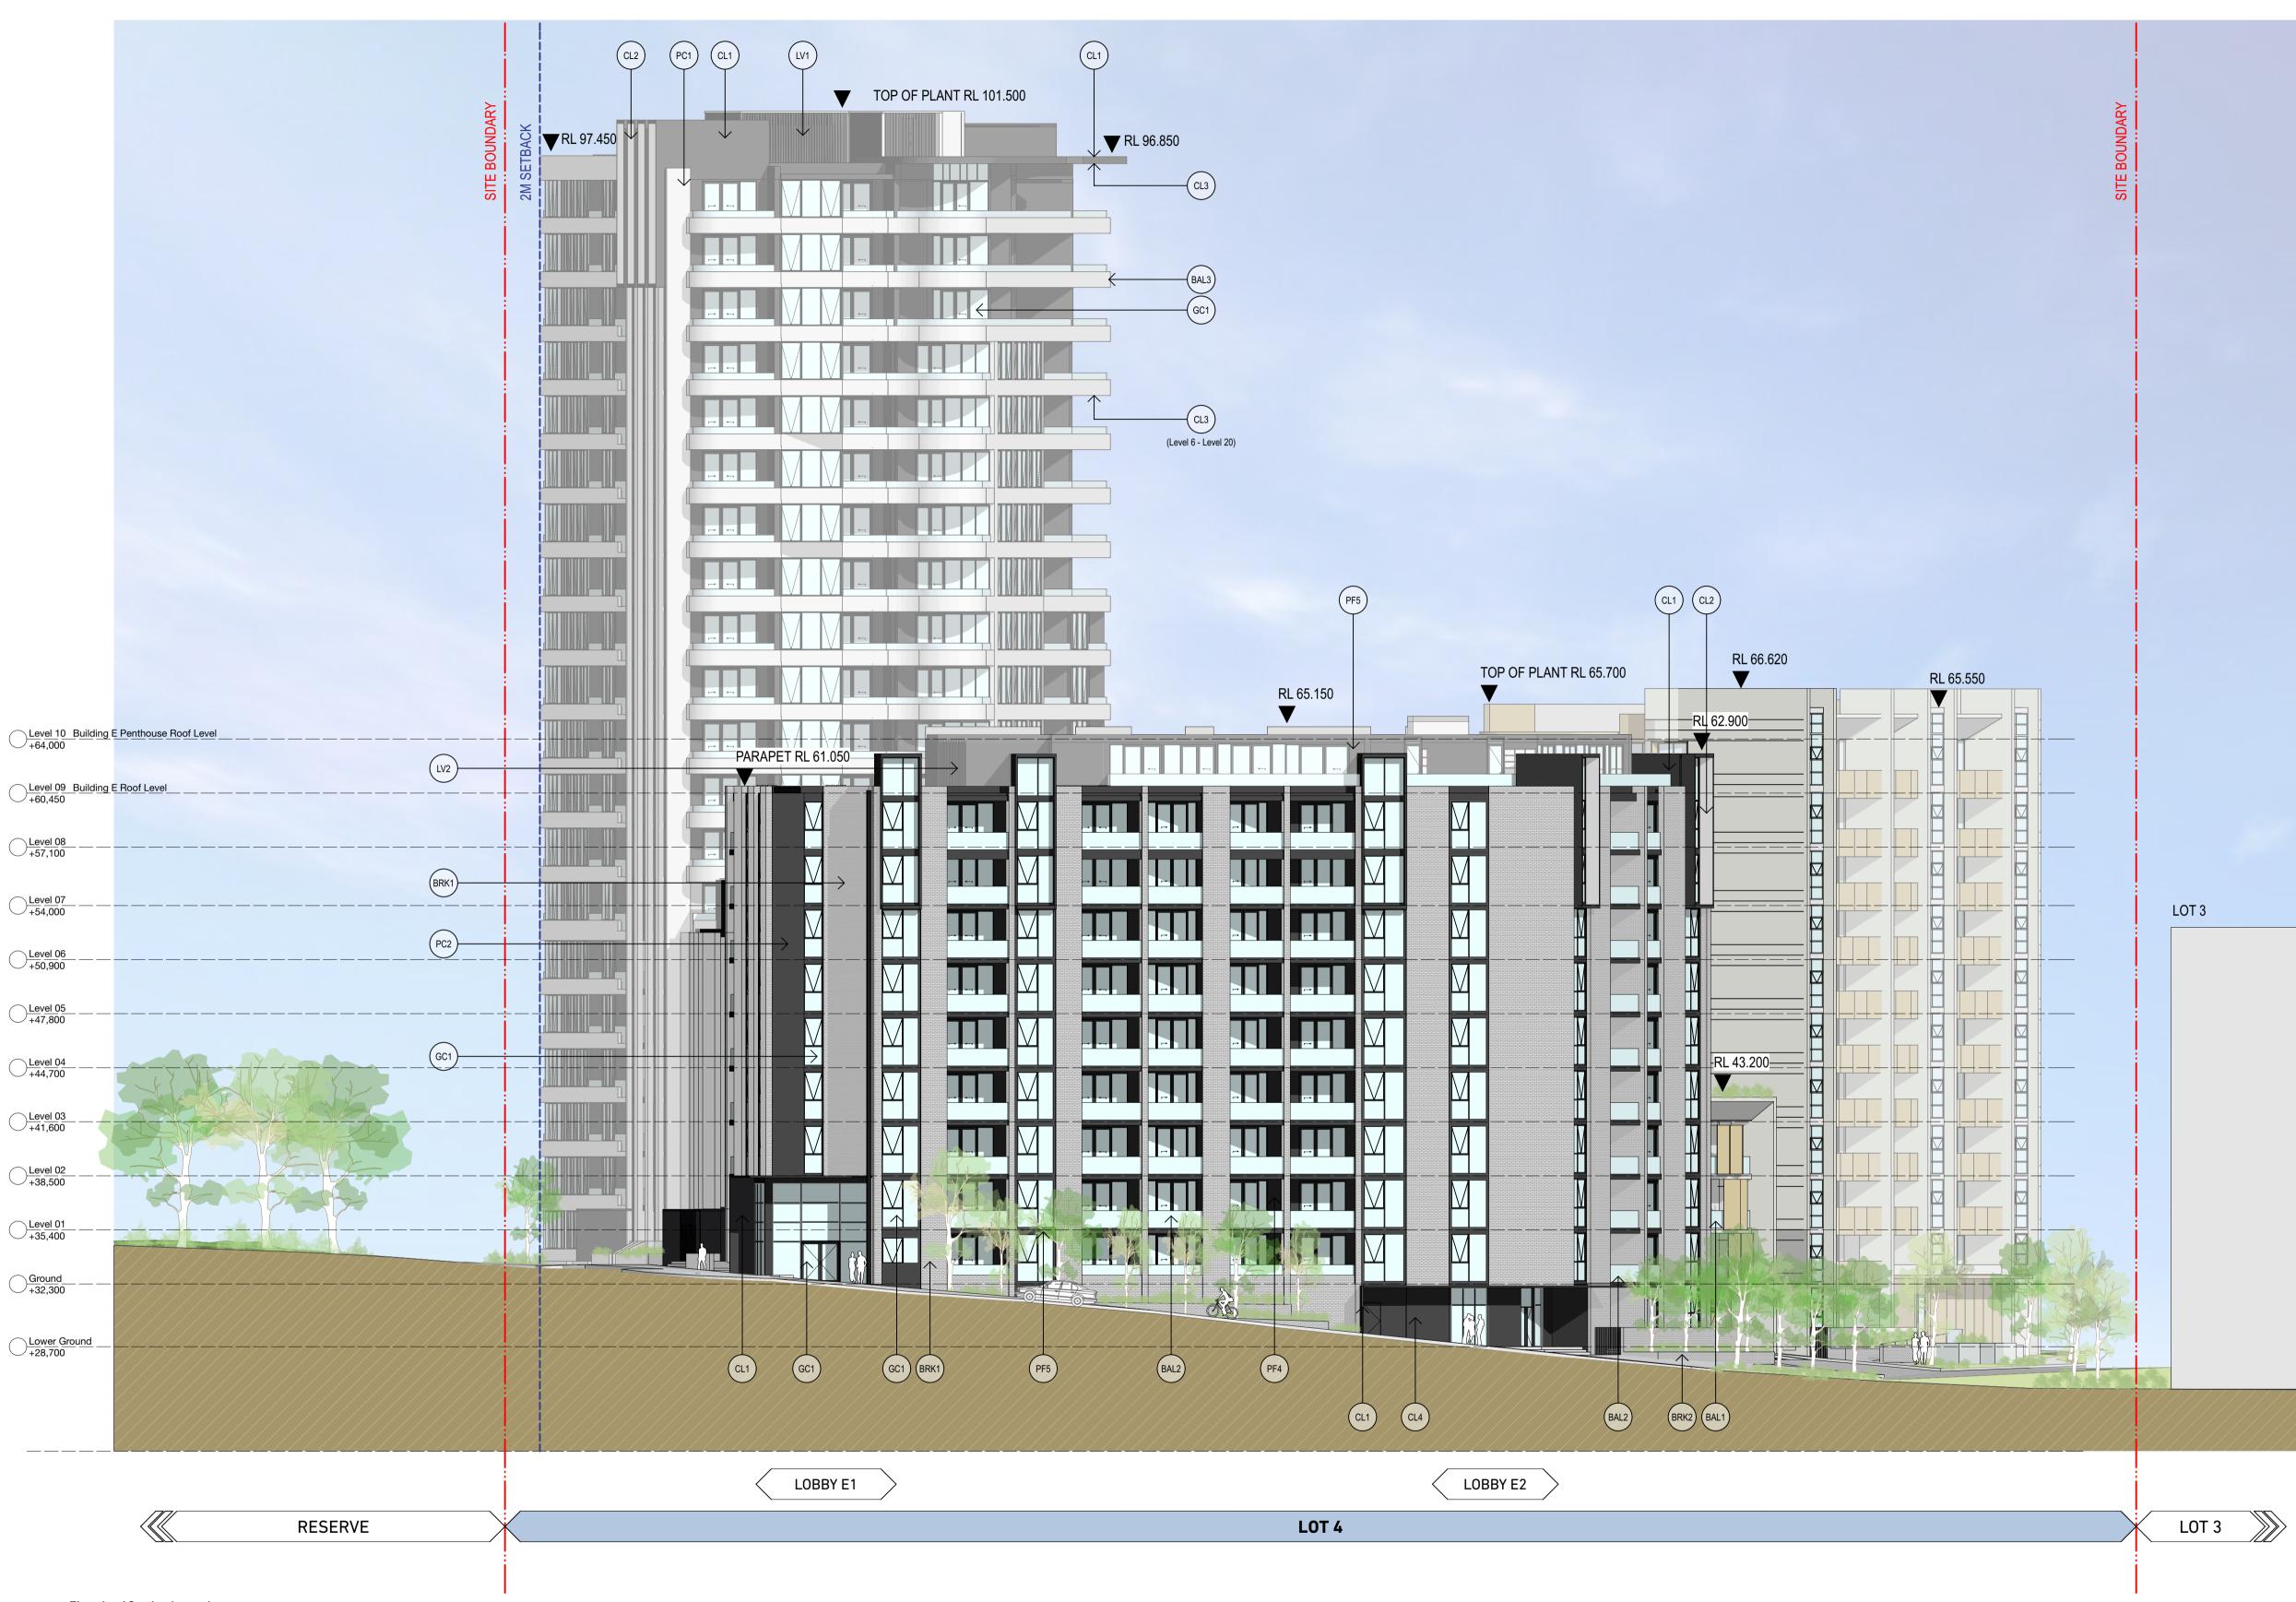

Elevation / Section Legend

- Balustrade Type 1: Semi-Frameless clear glass balustrade. Framing system, finish similar to PF1
- Balustrade Type 2: Semi-Frameless translucent glass balustrade. Framing system, finish similar to PF5
- Balustrade Type 3: Semi-Frameless clear glass balustrade fixed to solid spandrel panel/parapet wall. Framing system,

finish similar to PF1

- Balustrade Type 4:
 Perforated Architectural metal balustrade. Finish similar to PF7 + PF8
- BAL5 Balustrade Type 5: Fixed vertical metal fins. Finish similar to PF8
- Brick Type 1: Face brick similar in colour to Bowral 'Chillingham White'
- Brick Type 2:
 Glazed face brick to address landscaped areas Colour similar to Austral Bricks 'Allure- Lulu'
- COF1 Concrete, off form Clear finish or to landscape architect's specification
- Glass, Clear, Type 1:
 Glass, clear, to Basix and Acoustic report requirements. Aluminium framing system, finish similar to PF5
- Glass, Clear, Type 2: GC2 Glass, clear, 1902.

 Glass, clear, to Basix and Acoustic report requirements. Aluminium framing system, finish similar to PF3 CL1 Cladding Type 1:
 Metal cladding, colour similar to PF5
- CL2 Cladding Type 2:
 Metal cladding, colour similar to PF2
 - CL3 Cladding Type 3: Timber plastic composite cladding, similar to "spotted gum"
 - CL4 Cladding Type 4: FC cladding, colour similar to PF4

 - CL5 Cladding Type 5: Metal cladding, colour similar to PF8
 - CL6 Cladding Type 6:
 Metal cladding, colour similar to PF7 Glass, Translucent, Type 1:
 Glass, Translucent, to Basix and Acoustic report requirements.
 Aluminium framing system, finish similar to PF5
- Glass, Translucent, Type 2: Glass, Iranslucerii, Type Z.
 Glass, Translucent, to Basix and Acoustic report requirements.
 Aluminium framing system, finish similar to PF3
- GCB1 Glass, Colourback, Type 1:
 Glass, Dark Grey, to Basix and Acoustic report requirements. Aluminium framing system, finish similar to PF5
- GCB2 Glass, Colourback, Type 2: Glass, Dark Grey, to Basix and Acoustic report requirements. Aluminium framing system, finish similar to PF3
- LV1 Louvre Type 1: Fixed vertical louvre system. Aluminium, finish similar to PF2

Louvre Type 2: Fixed vertical louvre system. Aluminium, finish similar to PF5

- Louvre Type 3: Fixed vertical louvre system. Aluminium, finish similar to PF8
- Precast Concrete Type 1:
 Precast Concrete. Finish: penetrating low maintenance stain finish equal to Keim concrete Lasur system, similar to PF1
- Precast Concrete Type 2:
 Precast Concrete. Finish: penetrating low maintenance stain finish equal to Keim concrete Lasur system, similar to PF4
- Precast Concrete Type 3: (PC3) Vertical Profiled Precast Concrete. Finish: penetrating low maintenance stain finish equal to Keim concrete Lasur system, similar to PF1
- PC4 Precast Concrete Type 4:
 Natural Concrete. Finish with horizontal dummy joints Paint Finish Type 1:
- Finish similar to Dulux 'Natural White' Paint Finish Type 2: Finish similar to Dulux 'Flat White' powder coat

(PF1) Natural White

- PF3 Paint Finish Type 3: Finish similar to Dulux 'Flooded Gum'
- PF4 Paint Finish Type 4: Finish similar to Dulux 'Black Caviar'
- PF5 Paint Finish Type 5: Finish similar to Dulux powder coat 'Black Ace'
- PF6 Paint Finish Type 6: Finish similar to Dulux 'Harold'

Champagne' powder coat

- PF7 Paint Finish Type 7:
 Finish similar to Dulux Electro 'scintillation' powder coat Paint Finish Type 8: Finish similar to Dulux Electro 'Shimmering
- SC1 Screen Type 1:
 Aluminium slat fence, finish similar to PF2
- Screen Type 2:

 Metal louvered screen at mechanical air intake. Colour to match PF5
- Screen Type 3:
 Metal framed shedding structure with timber battens
- Screen Type 4:
 Vertical aluminium screen, finish to match PF5
- Screen Type 5:

 SC5 Metal louvered screen at mechanical

air intake. Colour to match PF1

Screen Type 6:

Metal louvered screen at mechanical air intake. Colour to match PF6

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DLCS Quality Endorsed Company ISO 9001:2008, Registration Number 20476 Nominated Architect: Nicholas Turner 6695, ABN 86 064 084 911

Thermal Comfort Specification		
Building Element	Material	Insulation
External Wall	Cavity Brick, Brick-Veneer, Concrete, Hebel	None, R1.0, R1.5*
Internal Wall	Plasterboard on Stud	None
Roof	Concrete	None
Ceiling	Concrete above Plasterboard	None, R2.5*
Floor	Concrete Slab	None, 0.5, 1.0*
EL 6 :	Carpet to Living and Bedrooms	21/2
Floor Coverings	Tiles to Bathrooms and Kitchens	N/A
Windows	Group A Glazed Systems:	N/A
	U-value = 6.7 & SHGC = 0.57, U- value = 5.4 & SHGC = 0.49*	
	Group B Glazed Systems:	

Draught seals to all external windows and doors Note: *Please refer to the BASIX Report for the individual insulation requirements of each

U-value = 6.7 & SHGC = 0.70, Uvalue = 5.4 & SHGC = 0.58*

residential dwelling





0001716160

24 July 2017

20887

WESTMEAD, NSW

Trong Thien Huynh

Rev. Date Approved by Revision Notes JM Development Application

JM Development Application Amendments 22.06.17 03.07.17 JM Development Application Amendments V 31.08.17 JM Development Application Amendments

CLIENT

Deicorp Level 3, 161 Redfern Street, Redfern NSW 2016, Australia


Project Title

WSU - Lot 4 158-164 Hawkesbury Road, 2a Darcy Road Westmead NSW 2145 Australia

Drawing Title **GA Elevations**

East Elevation 1:200 @A1, 50%@A3 turner DA-210-002 For Information

TURNER

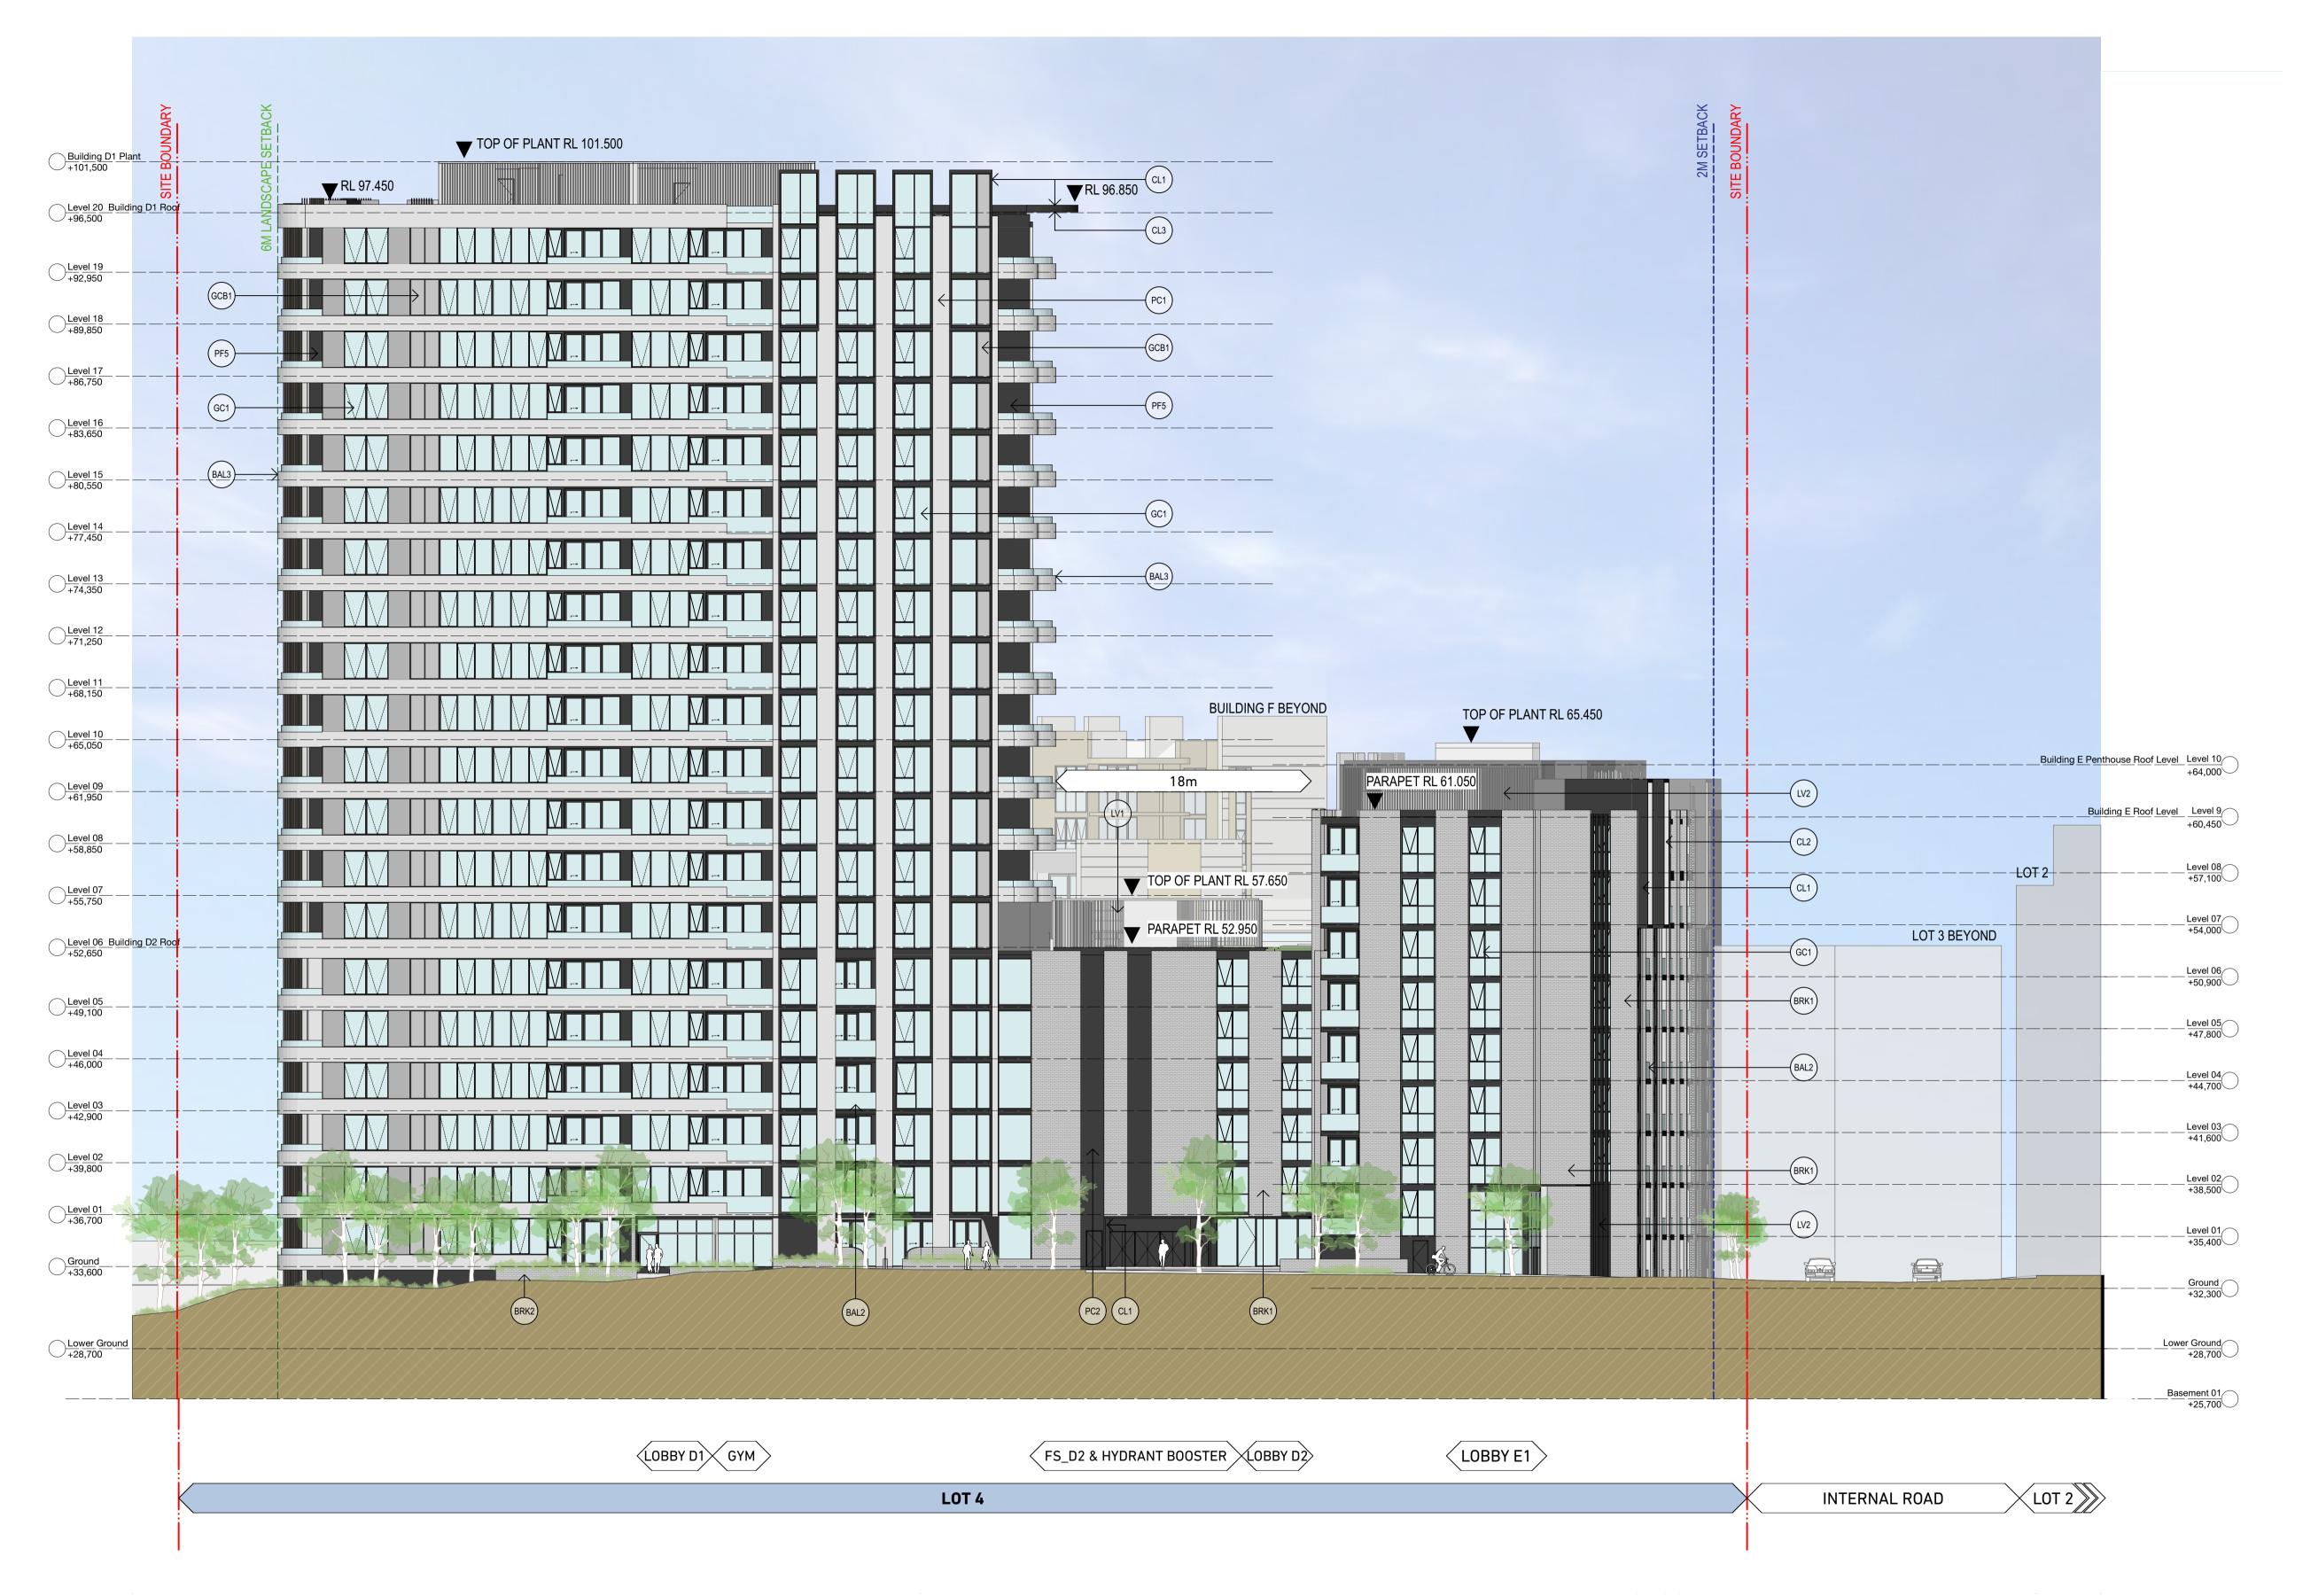

Elevation / Section Legend

- Balustrade Type 1:
 Semi-Frameless clear glass balustrade. Framing system, finish similar to PF1
- Balustrade Type 2: Semi-Frameless translucent glass balustrade. Framing system, finish similar to PF5
- Balustrade Type 3: Semi-Frameless clear glass balustrade fixed to solid spandrel panel/parapet wall. Framing system, finish similar to PF1
- Balustrade Type 4:
 Perforated Architectural metal balustrade. Finish similar to PF7 + PF8
- BAL5 Balustrade Type 5: Fixed vertical metal fins. Finish similar to PF8
- BRK1 Brick Type 1: Face brick similar in colour to Bowral 'Chillingham White'
- Colour similar to Austral Bricks 'Allure- Lulu'
- Glass, Clear, Type 1:
 Glass, clear, to Basix and Acoustic report requirements.
- Aluminium framing system, finish similar to PF5 Glass, Clear, Type 2: GC2 Glass, clear, to Basix and Acoustic report requirements.
- CL1 Cladding Type 1:
 Metal cladding, colour similar to PF5
- CL2 Cladding Type 2:
 Metal cladding, colour similar to PF2
- Brick Type 2:
 Glazed face brick to address landscaped areas
- COF1 Concrete, off form Clear finish or to landscape architect's specification CL4 Cladding Type 4: FC cladding, colour similar to PF4
 - CL5 Cladding Type 5: Metal cladding, colour similar to PF8
- Aluminium framing system, finish similar to PF3
- CL3 Cladding Type 3: Timber plastic composite cladding, similar to "spotted gum"
- CL6 Cladding Type 6:
 Metal cladding, colour similar to PF7
 - Glass, Translucent, Type 1:
 Glass, Translucent, to Basix and Acoustic report requirements.
 Aluminium framing system, finish similar to PF5
- GT2
 Glass, Translucent, Type 2:
 Glass, Translucent, to Basix and Acoustic report requirements.
 Aluminium framing system, finish similar to PF3
- GCB1 Glass, Colourback, Type 1:
 Glass, Dark Grey, to Basix and Acoustic report requirements. Aluminium framing system, finish similar to PF5
- GCB2 Glass, Colourback, Type 2:
 Glass, Dark Grey, to Basix and Acoustic report requirements. Aluminium framing system, finish similar to PF3
- Louvre Type 1: Fixed vertical louvre system. Aluminium, finish similar to PF2
- Louvre Type 2: Fixed vertical louvre system. Aluminium, finish similar to PF5 Louvre Type 3: Fixed vertical louvre system. Aluminium, finish similar to PF8
- Precast Concrete Type 1:
 Precast Concrete. Finish: penetrating low maintenance stain finish equal to Keim concrete Lasur system, similar to PF1
- Precast Concrete Type 2:
 Precast Concrete. Finish: penetrating low maintenance stain finish equal to Keim concrete Lasur system, similar to PF4
- Precast Concrete Type 3: (PC3) Vertical Profiled Precast Concrete. Finish: penetrating low maintenance stain finish equal to Keim concrete Lasur system, similar to PF1
- Precast Concrete Type 4:
 Natural Concrete. Finish with horizontal dummy joints
- Paint Finish Type 1: (PF1) Natural White Finish similar to Dulux 'Natural White'
- Paint Finish Type 2: Finish similar to Dulux 'Flat White' powder coat

- PF3 Paint Finish Type 3: Finish similar to Dulux 'Flooded Gum'
- PF4 Paint Finish Type 4: Finish similar to Dulux 'Black Caviar'
- PF5 Paint Finish Type 5: Finish similar to Dulux powder coat 'Black Ace'
- PF6 Paint Finish Type 6: Finish similar to Dulux 'Harold'
- PF7 Paint Finish Type 7:
 Finish similar to Dulux Electro 'scintillation' powder coat
- Paint Finish Type 8: Finish similar to Dulux Electro 'Shimmering Champagne' powder coat

- SC1 Screen Type 1:
 Aluminium slat fence, finish similar to PF2
- Screen Type 2:

 Metal louvered screen at mechanical air intake. Colour to match PF5
- Screen Type 3:
 Metal framed shedding structure with timber battens
- Screen Type 4:
 Vertical aluminium screen, finish to match PF5
- Screen Type 5:

 SC5 Metal louvered screen at mechanical air intake. Colour to match PF1 Screen Type 6:
 Metal louvered screen at mechanical

air intake. Colour to match PF6

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Ceiling	Concrete above Plasterboard	None, R2.5*
Floor	Concrete Slab	None, 0.5, 1.0*
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	Group B Glazed Systems:	
	U-value = 6.7 & SHGC = 0.70, U-	

value = 5.4 & SHGC = 0.58*

Draught seals to all external windows and doors Note: *Please refer to the BASIX Report for the individual insulation requirements of each

residential dwelling





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CLIENT Deicorp

Level 3, 161 Redfern Street, Redfern NSW 2016, Australia

Project Title

WSU - Lot 4 158-164 Hawkesbury Road, 2a Darcy Road Westmead NSW 2145 Australia

Drawing Title **GA Elevations**

For Information

South Elevation 16001 1:200 @A1, 50%@A3 turner DA-210-003

TURNER



Elevation / Section Legend

- Balustrade Type 1:
 Semi-Frameless clear glass balustrade. Framing system, finish similar to PF1
- Balustrade Type 2:
 Semi-Frameless translucent glass balustrade. Framing system, finish similar to PF5
- Balustrade Type 3: Semi-Frameless clear glass balustrade fixed to solid spandrel panel/parapet wall. Framing system,

finish similar to PF1

- Balustrade Type 4:
 Perforated Architectural metal balustrade. Finish similar to PF7 + PF8
- BAL5 Balustrade Type 5: Fixed vertical metal fins. Finish similar to PF8
- Brick Type 1: Face brick similar in colour to Bowral 'Chillingham White'
- Brick Type 2:
 Glazed face brick to address landscaped areas
- COF1 Concrete, off form Clear finish or to landscape architect's specification

Colour similar to Austral Bricks 'Allure- Lulu'

Glass, Clear, Type 1: Glass, clear, to Basix and Acoustic report requirements.

Glass, Clear, Type 2:

GC2 Glass, clear, to Basix and Acoustic report requirements. Aluminium framing system, finish similar to PF3 CL1 Cladding Type 1:
Metal cladding, colour similar to PF5

Aluminium framing system, finish similar to PF5

- CL2 Cladding Type 2:
 Metal cladding, colour similar to PF2
 - CL3 Cladding Type 3: Timber plastic composite cladding, similar to "spotted gum"
 - CL4 Cladding Type 4: FC cladding, colour similar to PF4
 - CL5 Cladding Type 5: Metal cladding, colour similar to PF8
 - CL6 Cladding Type 6: Metal cladding, colour similar to PF7
 - Glass, Translucent, Type 1:
 Glass, Translucent, to Basix and Acoustic report requirements.
 Aluminium framing system, finish similar to PF5
- Glass, Translucent, Type 2: Glass, Iranslucerii, Type Z.
 Glass, Translucent, to Basix and Acoustic report requirements.
 Aluminium framing system, finish similar to PF3
- GCB1 Glass, Colourback, Type 1:
 Glass, Dark Grey, to Basix and Acoustic report requirements. Aluminium framing system, finish similar to PF5
- GCB2 Glass, Colourback, Type 2:
 Glass, Dark Grey, to Basix and Acoustic report requirements. Aluminium framing system, finish similar to PF3
- Louvre Type 1: Fixed vertical louvre system. Aluminium, finish similar to PF2
- Louvre Type 2: Fixed vertical louvre system. Aluminium, finish similar to PF5 Louvre Type 3: Fixed vertical louvre system. Aluminium, finish similar to PF8
- Precast Concrete Type 1:
 Precast Concrete. Finish: penetrating low maintenance stain finish equal to Keim concrete Lasur system, similar to PF1
- Precast Concrete Type 2:
 Precast Concrete. Finish: penetrating low maintenance stain finish equal to Keim concrete Lasur system, similar to PF4
- Precast Concrete Type 3: (PC3) Vertical Profiled Precast Concrete. Finish: penetrating low maintenance stain finish equal to Keim concrete Lasur system, similar to PF1
- Precast Concrete Type 4:
 Natural Concrete. Finish with horizontal dummy joints
- Paint Finish Type 1: (PF1) Natural White Finish similar to Dulux 'Natural White' Paint Finish Type 2: Finish similar to Dulux 'Flat White' powder coat
- PF3 Paint Finish Type 3: Finish similar to Dulux 'Flooded Gum'
- PF4 Paint Finish Type 4: Finish similar to Dulux 'Black Caviar'
- PF5 Paint Finish Type 5: Finish similar to Dulux powder coat 'Black Ace'
- PF6 Paint Finish Type 6: Finish similar to Dulux 'Harold'
- PF7 Paint Finish Type 7:
 Finish similar to Dulux Electro 'scintillation' powder coat
- Paint Finish Type 8: Finish similar to Dulux Electro 'Shimmering Champagne' powder coat

- SC1 Screen Type 1:
 Aluminium slat fence, finish similar to PF2
- Screen Type 2:

 Metal louvered screen at mechanical air intake. Colour to match PF5
- Screen Type 3:
 Metal framed shedding structure with timber battens
- Screen Type 4:
 Vertical aluminium screen, finish to match PF5
- Screen Type 5:

 SC5 Metal louvered screen at mechanical

air intake. Colour to match PF1

Screen Type 6:

SC6 Metal louvered screen at mechanical air intake. Colour to match PF6

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DLCS Quality Endorsed Company ISO 9001:2008, Registration Number 20476 Nominated Architect: Nicholas Turner 6695, ABN 86 064 084 911

Thermal Comfort Specification			
Building Element	Material	Insulation	
External Wall	Cavity Brick, Brick-Veneer, Concrete, Hebel	None, R1.0, R1.5	
Internal Wall	Plasterboard on Stud	None	
Roof	Concrete	None	
Ceiling	Concrete above Plasterboard	None, R2.5*	
Floor	Concrete Slab	None, 0.5, 1.0*	
Floor Coverings	Carpet to Living and Bedrooms	N/A	
	Tiles to Bathrooms and Kitchens	•	
Windows	Group A Glazed Systems:	N/A	
	U-value = 6.7 & SHGC = 0.57, U-		

value = 5.4 & SHGC = 0.58* Draught seals to all external windows and doors Note: *Please refer to the BASIX Report for the individual insulation requirements of each

value = 5.4 & SHGC = 0.49* Group B Glazed Systems:

U-value = 6.7 & SHGC = 0.70, U-

residential dwelling





JM Development Application Amendments JM Development Application Amendments 0001716160

24 July 2017

20887

Trong Thien Huynh

Rev. Date Approved by Revision Notes JM Development Application Amendments 22.06.17

03.07.17

Deicorp Level 3, 161 Redfern Street, Redfern NSW 2016, Australia

Project Title

WSU - Lot 4 158-164 Hawkesbury Road, 2a Darcy Road Westmead NSW 2145 Australia

Drawing Title **GA Elevations**

West Elevation 1:200 @A1, 50%@A3 turner DA-210-004 For Information

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